


DOOR SCHEDULE					TH	THK. MAT'L.			RATIN	RATING FRAME		ME		Ż	լ	30LT					
DOOR NUMBER	DOOR ACTION	TYPE P		DOR SIZE	E HEIGHT	1-15/16" 1-3/4"	1-3/8"	H.M.	ALUM/GLASS	1-1/2 HR 1-HR 3//1 LB	20 MIN.	NON NON	ALUMINUM	WOOD	AUTO. CLOSER	PANIC DEVICE SOUND DEADEN'	WEATHERSTRI	KEYED DEAD E	KITL-LOCK	PRIVACY LOCK	REMARKS
	SWING			3'-0"	8'-0"	•			•			•	•		•		H	• •		\blacksquare	EXTERIOR. MAIN ENTRANCE, WITH SIDELITE
2	SWING			3'-0"	8'-0"	•)	•				• •	•		•		•	• •	•		EXTERIOR, SECUNDARY ENTRANCE/ EXIT
3	SWING			3'-0"	8'-O"		•	•		•		٦,	•		•			•	•		INTERIOR, GROUND FLOOR STAIR ENCLOSURE
4	SWING			3'-0"	8'-0"		•	•				•		•					•	•	INTERIOR, OFFICES, TOILETS
5	SWING			2'-6"	8'-0"		•	•				•		•					•		INTERIOR, CLOSET
6	SWING			3'-O"	8'-O"		•	•		•		1			•			•	•		INTERIOR, 2ND. FLOOR STAIR ENCLOSURE
7	SWING		•	3'-0"	8'-0"	•	•	•		•		1			•			•	•		INTERIOR, 2ND FLOOR STORAGE (SERVICE DOOR)

H.C. - HOLLOW CORE K.I.T.L. - KEY IN THE LOCKSET

FIXED GLASS SCHEDULE										
Y H				WINDOV	W SIZES		WINDOW FABRICATION			
MARK	QUAI	MULT	STANDARD WINDOW DESCRIPTION	WIDTH	HEIGHT	SILL HEIGHT A.F.F.	FRAME	GLASS THKNS	GLASS TINT	REMARKS
(A)			FIXED GLASS	5'-4"	5'-O"	2'-10"	ALUM.	3/16"		EXTERIOR, CAT. II SAFETY GLASS
B			FIXED GLASS	4'-4"	5'-O"	2'-10"	ALUM.	3/16"		EXTERIOR, CAT. II SAFETY GLASS

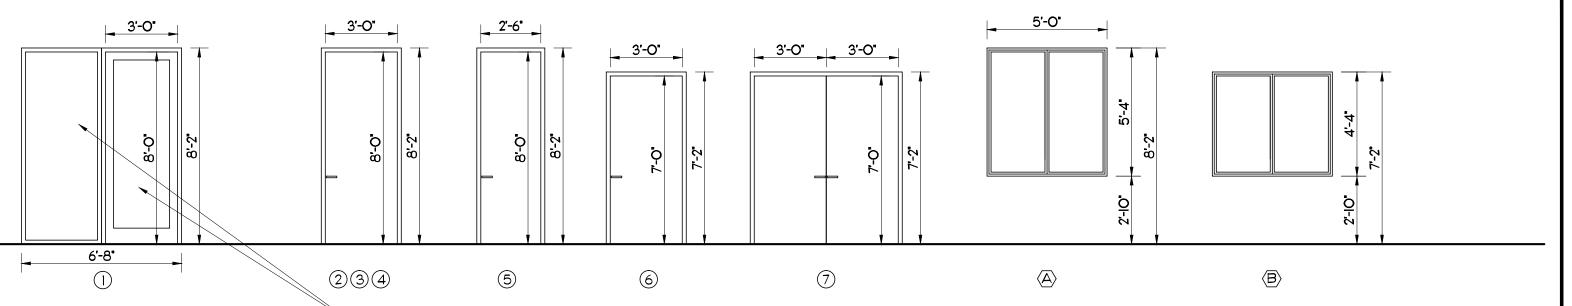

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DOOR NOTES:

DOOR AND FIXED GLASS ELEVATIONS

EXTERIOR DOORS: ALL EXTERIOR DOORS SHALL HAVE AUTO-CLOSER

DOOR HANDLES: ALL DOOR HANDLES SHALL BE LEVER TYPE

DOOR WIDTH: NO DOOR OPENING IN THE MEANS OF EGRESS SHALL BE LESS THAN 32 IN. NOR WIDER THAN 48 IN. WHERE A PAIR OF DOORS IS PROVIDED, AT LEAST ONE OF THE DOORS SHALL PROVIDE A MINIMUM 32 IN. CLEAR WIDTH OPENING.

IMPACT RESISTANT CAT II

SAFETY GLASS (TYP)

DOOR OPENING FORCE: THE FORCE REQUIRED TO FULLY OPEN ANY DOOR MANUALLY IN A MEANS OF EGRESS SHALL NOT EXCEED 15 LBF. TO RELEASE THE LATCH, 30 LBF. TO SET THE DOOR IN MOTION, AND 15 LBF. TO OPEN THE DOOR TO THE MIN. REQUIRED WIDTH. FORCE SHALL BE APPLIED TO THE LATCH STILE.

DOOR FINISH: UNLESS OTHERWISE INSTRUCTED BY THE OWNER, ALL WOOD DOORS AND FRAMES SHALL BE PAINT-GRADE QUALITY FINISH. 2010 FBC 1008.1.9.5 REQUIREMENT: ONLY ONE (I) LOCKING OR LATCHING DEVICE SHALL BE PERMITTED ON AN EXIT DOOR. TOILET DOORS: PROVIDE PRIVACY LOCK AT TOILET LOCATION.

LL EXTERIOR DOORS AND WINDOWS SHALL BE IMPACT RESISTANT AND SHALL HAVE CAT. II SAFETY GLASS

F.B.C. 2411.3.1.3 DOORS AND OPERATIVE WINDOWS IN INTERIOR WALLS. GLAZING IN SLIDING AND SWING DOORS SHALL BE SAFETY - GLAZING COMPLYING WITH 16 CFR 1201 SAFETY STANDARD FOR ARCHITECTURAL GLAZING MATERIALS, CONSUMER PRODUCT SAFETY COMMISSION, AND AS DESCRIBED IN 2411.3.1.3.1 THROUGH 2411.3.1.3.5.

FINISH SCHEDULE WALLS CEILING CARPENTRY MATERIAL MATER. REMARKS AND NOTES MATER. BASE CROWN HEIGHT FINISH FINISH SILL MATER. EXTERIOR AREAS STUCCO PAINT PAINT EXTERIOR COVERED CORRIDOR CONC. | EXPOSED | BROOM CMU 8'-2" STUCCO INTERIOR AREAS YP. WBD GYP. WBD PAINT RECEPTION / WORK AREA CONC. | CER. TILE | 9'-0" AC. CLG SYP. WBD GYP. WBD PAINT OFFICES CONC. | CER. TILE | VINYL 9'-0" AC. CLG THE WARD WARD PAINT LOUNGE CONC. CER. TILE 9'-0" AC. CLG YP. WBD GYP. WBD PAINT FILING ROOM CER. TILE 9'-0" GWB / AC. CLG | PAINT / -SEE SECTIONS FOR DETAILS CONC. GYP. WBD GYP. WBD PAINT CLOSET 9'-0" CONC. CER. TILE AC, CLG GYP. WBD WRGWB PAINT OFFICE TOILET CONC. CER. TILE AC. CLG 9'-0" GYP. WBD WRGWB PAINT STORAGE TOILET CONC. | CER. TILE | AC. CLG GROUND FLOOR STORAGE CONC. | EXPOSED | BROOM CMU 21'-5" GYP. WBD GYP. WBD PAINT CONC. | EXPOSED | BROOM | STAIR VARIES 2ND FLOOR STORAGE CONC. | EXPOSED | BROOM | 10'-5" GYP. WBD

ABBREVIATIONS:

CER. TILE - CERAMIC TILE C.M.U. - CONCRETE MASONRY UNIT

V.C.T. - VINYL COMPOSITE TILE AC. CLG - SUSPENDED ACOUSTICAL CEILING

LAM. WD - LAMINATED WOOD GYP. WBD - GYPSUM WALLBOARD

WRGWB - WATER RESISTANT GYPSUM WALLBOARD

PROVIDE WATER RESISTANT GYPSUM WALLBOARD IN ALL THE PARTITIONS WHERE SINKS ARE LOCATED.

CEILING NOTES:

"LAY-IN" ALL CEILINGS: 24" X 24" X 5/8" ACOUSTICAL PANELS

TOILET NOTES:

WALL FINISH: WALLS WITHIN 2 FEET OF URINALS AND WATER CLOSETS SHALL HAVE A SMOOTH, HARD, NONABSORBENT SURFACE (TILES OR EPOXY PAINT), TO A HEIGHT OF 4 FT ABOVE THE FLOOR. ACCESSORIES SUCH AS GRAB BARS, TOWEL BARS, PAPER DISPENSERS AND SOAP DISHES, PROVIDED ON OR WITHIN WALLS, SHALL BE INSTALLED AND SEALED TO PROTECT STRUCTURAL ELEMENTS FROM MOISTURE. (1210.2 FBC 2010)

SHALL COMPLY WITH FBC SECTION 803 FBC-2010 (BUSINESS AND STORAGE OCCUPANCIES- NON SPRINKLERED)

MINIMUM INTERIOR FINISH CLASSIFICATION (TABLE 803.9)

OCCUPANCY	NONSPRINKLERED							
	EXIT ENCLOSURES AND PASSAGEWAYS	CORRIDORS	ROOMS AND ENCLOSED SPACES					
BUSINESS (B)	А	В	C					
STORAGE (S-2)	В	В	С					

CLASS A: FLAME SPREAD INDEX 0-25, SMOKE-DEVELOPED INDEX 0-450

CLASS B: FLAME SPREAD INDEX 26-75.

SMOKE-DEVELOPED INDEX 0-450

CLASS C: FLAME SPREAD INDEX 76-200, SMOKE-DEVELOPED INDEX 0-450

CONTRACTOR TO VERIFY MASONRY OPENINGS

THE ACTUAL AS-BUILT CONDITION.

- . THE CONTRACTOR SHALL COORDINATE AND VERIFY THE EXACT DIMENSION OF THE MASONRY OPENINGS WITH THE SELECTED WINDOW AND DOOR ASSEMBLIES, IN ANY AND ALL CASES. THE CONTRACTOR SHALL NOT DEPEND ON THE INFORMATION GIVEN IN THESE PLANS AND SCHEDULES FOR THE PURPOSE OF COORDINATING THIS WORK FOR CONSTRUCTION. THE MEANS AND METHODS OF CONSTRUCTION ARE, AND SHALL REMAIN, THE CONTRACTOR'S RESPONSIBILITY.
- 2. THE CONTRACTOR SHALL CONFIRM THE CURRENT BUILDING DEPARTMENT REQUIREMENTS AS TO THE ALLOWABLE SIZE AND SHAPE WOOD BUCKS AND THE REQUIRED ANCHORING FOR THE BUCKS FOR ALL DOORS AND WINDOWS. THIS INFORMATION SHALL BE COORDINATED BY THE CONTRACTOR WITH THE SELECTED MANUFACTURER'S INFORMATION TO PROVIDE THE MOST EXACT AND BEST FITTING OPENING.
- THE CONTRACTOR SHALL VERIFY THE INFORMATION PROVIDED IN THE DOOR AND WINDOW SCHEDULES. THE DIMENSIONS SHOWN ON THE FLOOR PLANS HAVE BEEN ROUNDED-OFF ONLY FOR THE PURPOSE OF ESTABLISHING THE GENERAL LOCATION OF
- OPENINGS ON THE ARCHITECTURAL AND STRUCTURAL DRAWINGS. 4. THE CONTRACTOR SHALL SUBMIT MIAMI-DADE "PRODUCT CONTROL NOTICE OF ACCEPTANCE (NOA)" FOR EACH OF THE TYPES OF WINDOWS AND EXTERIOR DOORS INDICATED ON DRAWINGS TO ARCHITECT AND BUILDING DEPARTMENT FOR APPROVAL
- AND PERMIT PRIOR TO INSTALLATION. 5. THE MANUFACTURER SPECIFIED, IF ANY, (AND ANY MODEL NUMBERS, IF PROVIDED) ARE INTENDED ONLY AS A GENERAL GUIDELINE TO ESTABLISH A DESIGN STANDARD. IN THE EVENT OF A CHANGE IN THE SPECIFIED DOOR OR WINDOW MANUFACTURER(S) THE PLANS AND SCHEDULES SHOULD BE REVISED SO THAT THE (FINAL) PERMIT DRAWINGS REFLECTS

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ARCHITECTURE

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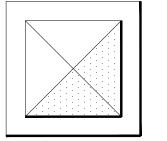
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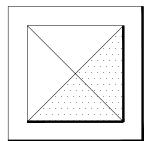
SCHEDULES	
DRAWN BY:	ISSUE DATE:

DRAWN BY:	ISSUE DATE:
L. CAPOTE	10-15-14
PROJECT NO.	SCALE:
14572-2	AS SHOWN
ARCHITECT OR ENGINEER OF	RECORD:

JORGE S. AZZE 09688

A-I	SCHEDULES
A6-OI	SCALE: N.T.S.





New 2-Story Building for an Existing Industrial Property

Folio Numbers: 04-3105-004-0370 and 04-3105-001-1120

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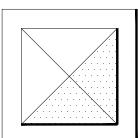
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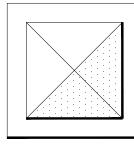
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