


CONSTRUCTION LEGEND

- ① REQ'D 4" BARRIER CURB (SEE JEFFERSON PARISH DEPARTMENT OF ENGINEERING CURB AND CURB AND GUTTER DETAILS)
- ② REQ'D DRAIN INLET (SEE JEFFERSON PARISH DEPARTMENT OF ENGINEERING DRAINAGE STANDARD DETAILS, SHEET 3 OF 3)
- ③ REQ'D 6" CONCRETE PAVEMENT (SEE DETAIL 1, DWG. C9)
- ④ REQ'D DRAIN MANHOLE (SEE JEFFERSON PARISH DEPARTMENT OF ENGINEERING DRAINAGE STANDARD DETAILS, SHEET NO. 1 OF 3)
- ⑤ REQ'D DUMPSTER PAD INLET (SEE DETAIL 1, DWG. C8)
- ⑥ REQ'D BARRIER CURB AND GUTTER (SEE JEFFERSON PARISH DEPARTMENT OF ENGINEERING CURB AND CURB AND GUTTER DETAILS)
- ⑦ SEE DETAIL OF JEFFERSON PARISH DEPART. OF ENG. STANDARD DETAILS FOR CONNECTING DRIVEWAYS TO EXIST. ROADWAYS
- ⑧ THE NEW BARRIER CURB INTO EXIST. BARRIER CURB (SEE DETAIL 4, DWG. C9)
- ⑨ ADJUST SEWER MANHOLE LID (SEE GRADING PLAN)
- ⑩ REINFORCED CONCRETE SLAB (SEE DETAIL 4, DWG. C9)
- ⑪ REQ'D CONCRETE SIDEWALK (SEE JEFFERSON PARISH DEPARTMENT OF ENGINEERING TYPICAL SIDEWALK DETAIL)
- ⑫ REQ'D DUMPSTER ENCLOSURE (SEE DWG. C10)

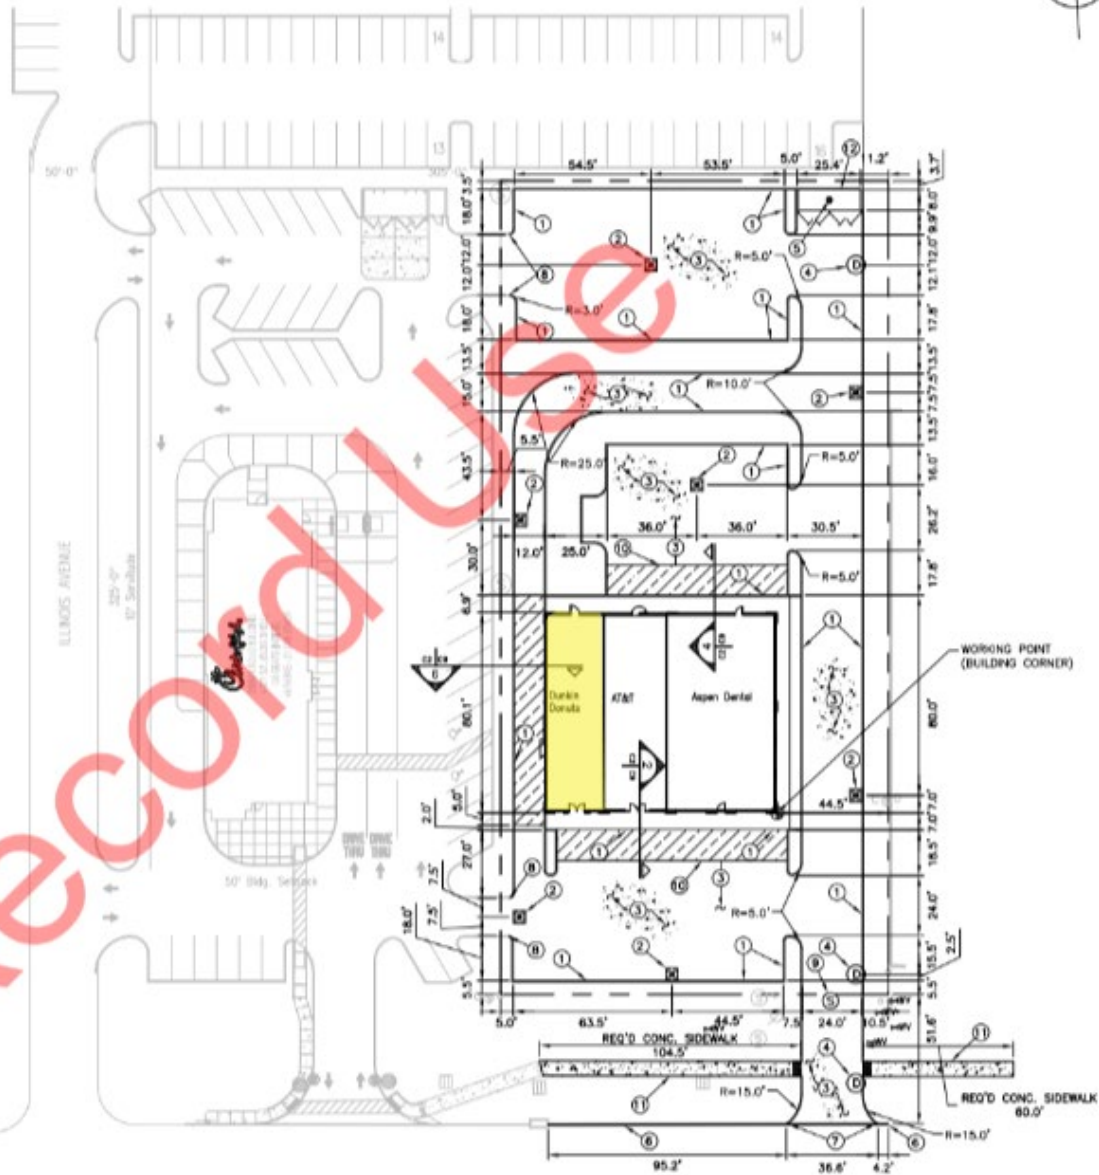

NOTES:

- 1. CONTRACTOR SHALL BE RESPONSIBLE FOR LAYING OUT THE WORK, VERIFYING ALL MEASUREMENTS AND GRADES AND REPORTING ANY DISCREPANCIES TO THE ENGINEER BEFORE STARTING CONSTRUCTION.
- 2. ANY WORK IN THE ROADWAY OR ADJACENT TO THE ROADWAY CAUSING AN INTERFERENCE TO VEHICULAR TRAFFIC REQUIRES PRIOR NOTIFICATION TO THE CITY OF KIPPER AND JEFFERSON PARISH PUBLIC WORKS DEPARTMENT AND CONFORMITY TO THE REQUIREMENTS OF THE MANUAL ON UNIFORM TRAFFIC CONTROL DEVICES. THE CONTRACTOR MUST FURNISH ALL TRAFFIC SIGNS AND/OR BARRIAGES AND MAINTAIN THEM DURING CONSTRUCTION ACTIVITY.
- 3. REFER TO BOUNDARY SURVEY FOR EXISTING MONUMENTS TO LAYOUT PROPERTY LINE.
- 4. BRING UP GRADE UNDER ALL PAVEMENT WITH STRUCTURAL FILL COMPACTED IN ACCORDANCE WITH SPECIFICATIONS.
- 5. ALL DIMENSIONS SHOWN ARE FROM:
 - FACE OF CURB TO FACE OF CURB
 - FACE OF CURB TO PROPERTY LINE
 - FACE OF CURB TO CENTER OF STRUCTURE (DRAIN INLET, MANHOLE, ETC.)
 - PROPERTY LINE TO BUILDING FACE
- 6. ALL CURB RADI SHALL BE 2 FEET UNLESS OTHERWISE NOTED ON THIS PLAN.
- 7. SEE STRUCTURAL FOR DETAIL OF DUMPSTER PAD.

CIVIL SITE PLAN

SCALE: 1" = 30'